

, METRIC ALL DIMENSIONS AND ELEVATIONS ARE IN METRES UNLESS OTHERWISE SHOWN



ELEVATIONS SHOWN HERE ON ARE GEODETIC AND ARE DERIVED FROM NRCCAN PRECISE POINT POSITIONING STATIC GPS OBSERVATIONS. PLEASE REFER TO ORIGINAL TOPOGRAPHICAL SURVEY BY GUIDO PAPA SURVEYORS LTD. (PROJECT NO. 14-531) FOR FURTHER DETAILS.

	ISSUED FOR TOWN SITE PLAN APPROVAL	P.F.A.	10 JAN 2023
).	REVISION	BY	DATE

REVISIONS

MOUNT ALBERT INVESTMENT CORPORATION



fabian papa & partner 3901 Highway 7, Suite 500 Vaughan, Ontario, L4L 8L5 t: 905-264-2420

TOWN OF EAST GWILLIMBURY ENGINEERING AND CONSTRUCTION SERVICES

23 PRINCESS STREET INDUSTRIAL PROPERTY USE

SITE PLAN




DWN. BY:	P.F.A.
DESIGNED BY:	P.F.A.
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SCALE:	1:300
DATE: DE	C. 2022
SHEET NO: 1	OF 3

14135

SP-1

REV. NO.

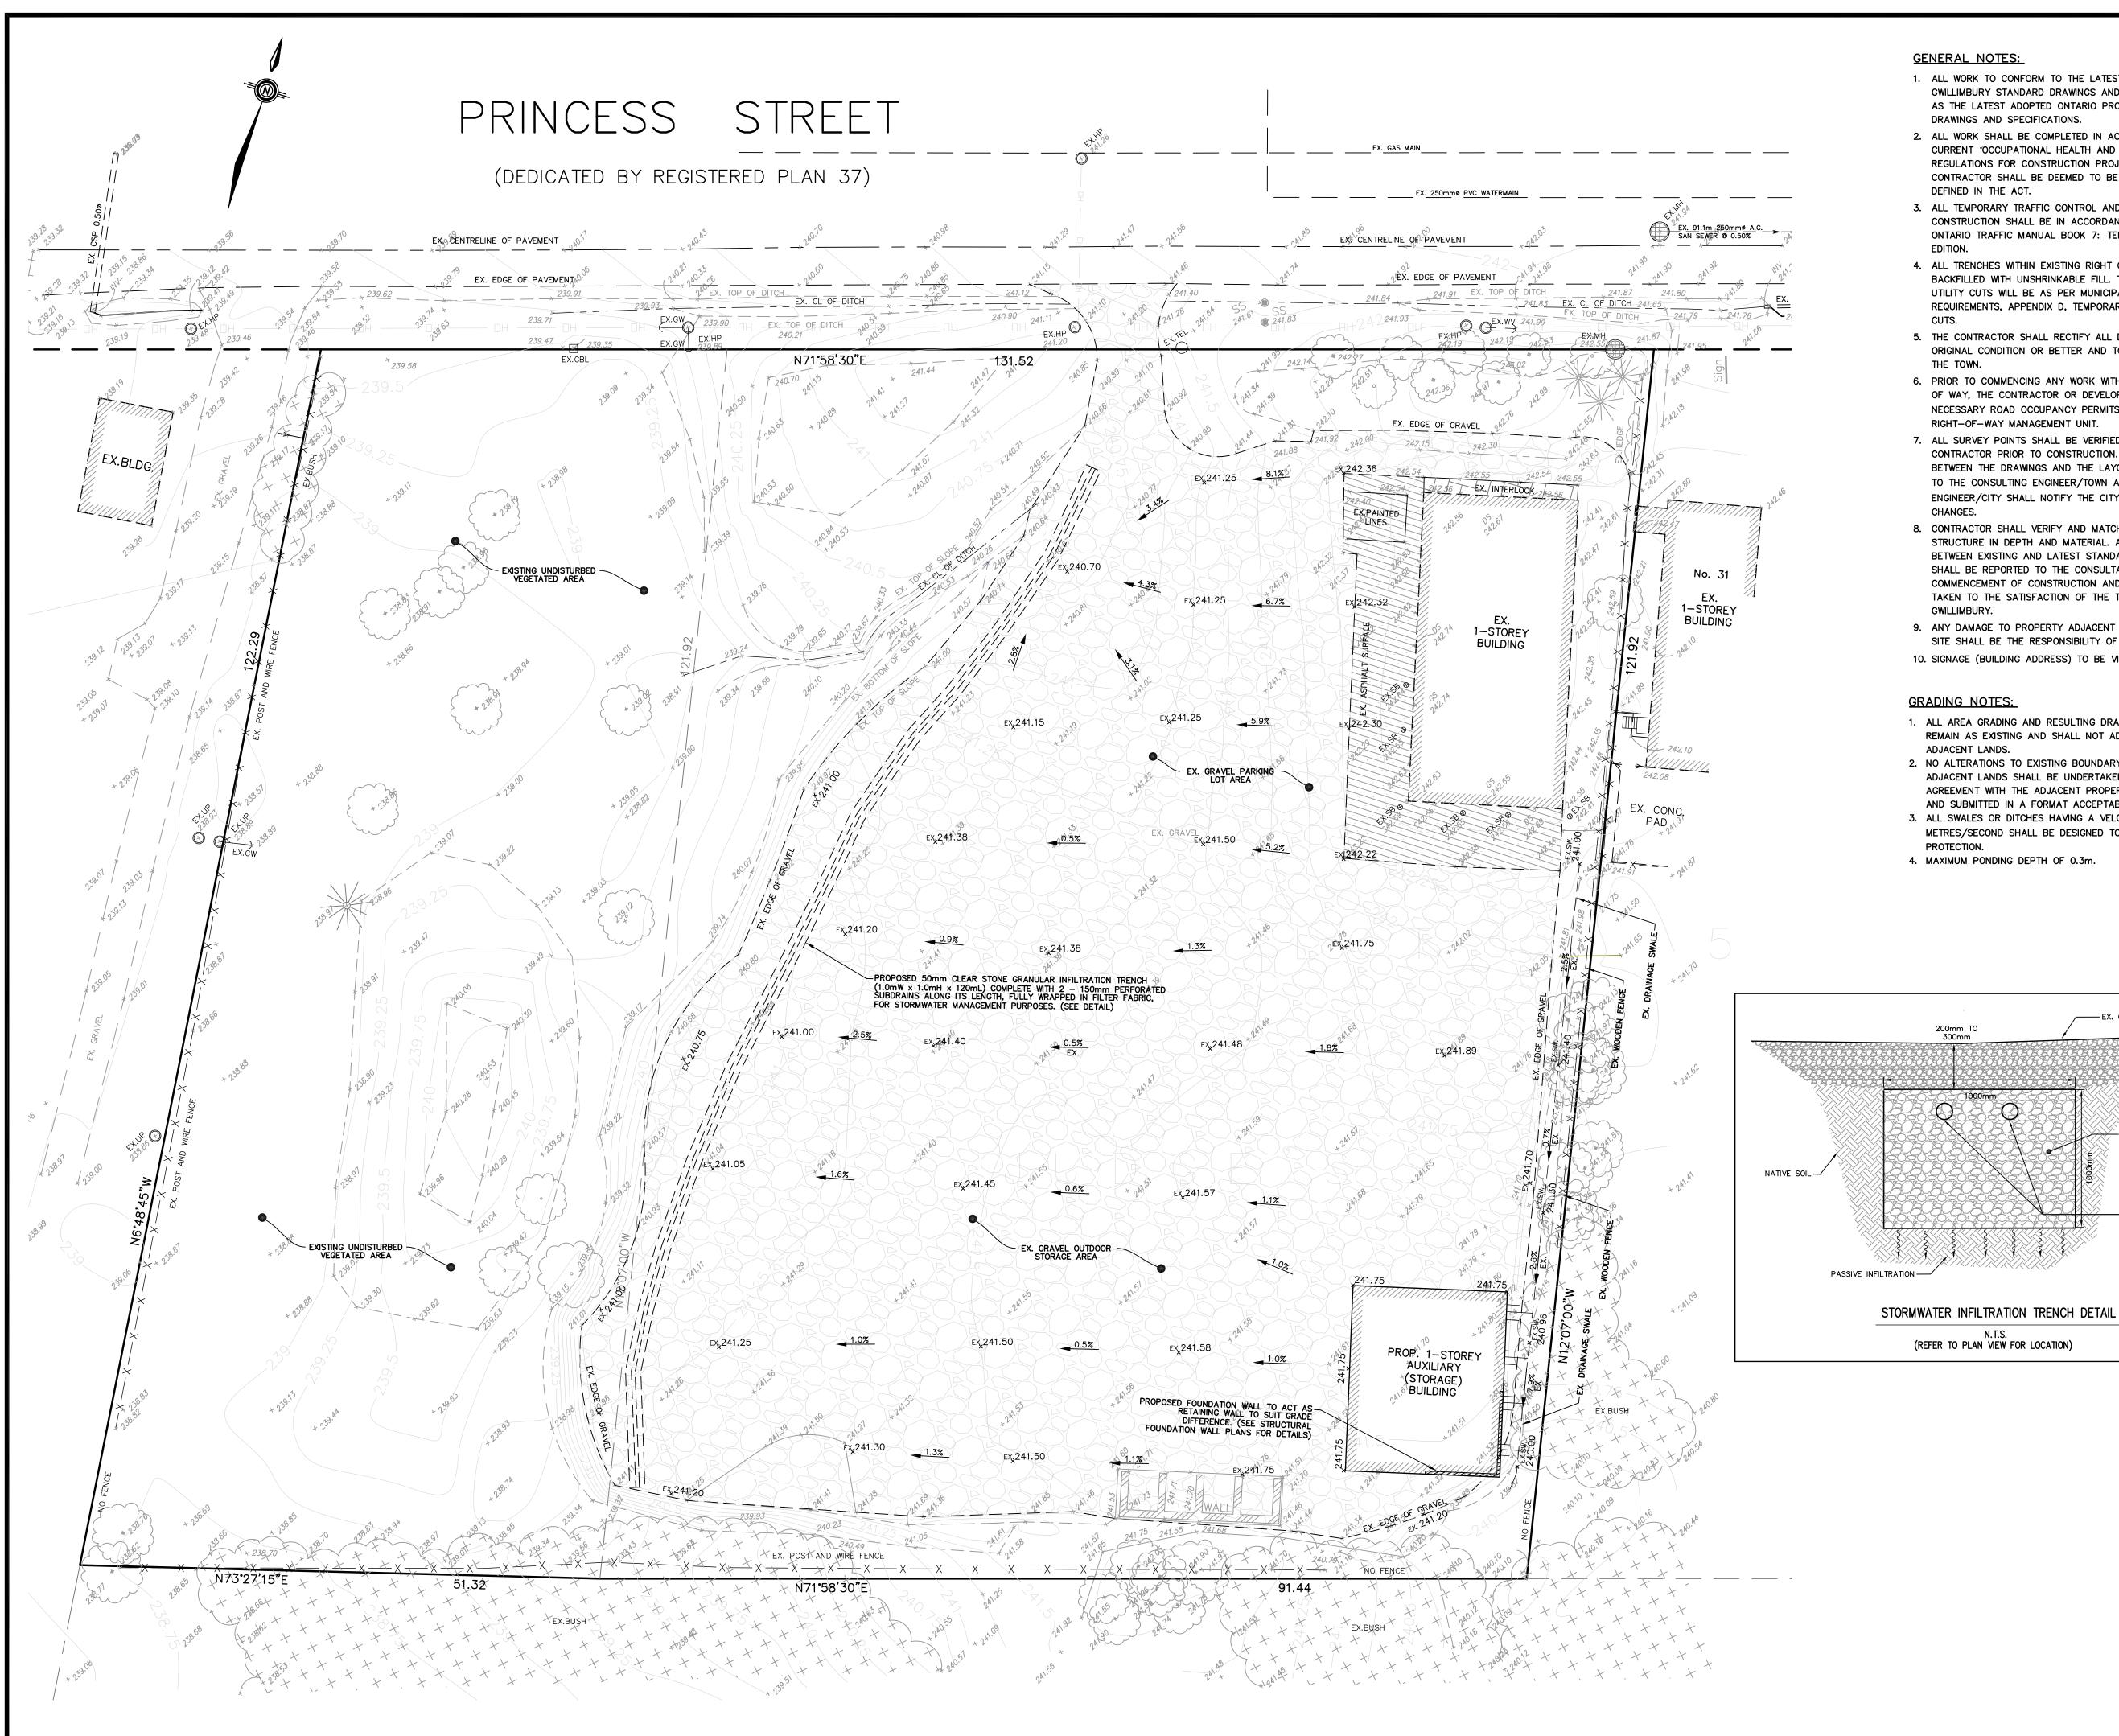

#### **GENERAL NOTES:**

- 1. ALL WORK TO CONFORM TO THE LATEST TOWN OF EAST GWILLIMBURY STANDARD DRAWINGS AND SPECIFICATIONS AS WELL AS THE LATEST ADOPTED ONTARIO PROVINCIAL STANDARD DRAWINGS AND SPECIFICATIONS.
- 2. ALL WORK SHALL BE COMPLETED IN ACCORDANCE WITH THE CURRENT "OCCUPATIONAL HEALTH AND SAFETY ACT AND REGULATIONS FOR CONSTRUCTION PROJECTS". THE GENERAL CONTRACTOR SHALL BE DEEMED TO BE THE CONSTRUCTOR AS DEFINED IN THE ACT.
- 3. ALL TEMPORARY TRAFFIC CONTROL AND SIGNAGE DURING CONSTRUCTION SHALL BE IN ACCORDANCE WITH CURRENT ONTARIO TRAFFIC MANUAL BOOK 7: TEMPORARY CONDITIONS FIELD
- 4. ALL TRENCHES WITHIN EXISTING RIGHT OF WAY SHALL BE BACKFILLED WITH UNSHRINKABLE FILL. TEMPORARY REPAIRS TO UTILITY CUTS WILL BE AS PER MUNICIPAL CONSENT REQUIREMENTS, APPENDIX D, TEMPORARY REPAIRS TO UTILITY
- 5. THE CONTRACTOR SHALL RECTIFY ALL DISTURBED AREAS TO THE ORIGINAL CONDITION OR BETTER AND TO THE SATISFACTION OF THE TOWN.
- 6. PRIOR TO COMMENCING ANY WORK WITHIN THE MUNICIPAL RIGHT OF WAY, THE CONTRACTOR OR DEVELOPER WILL OBTAIN ALL NECESSARY ROAD OCCUPANCY PERMITS FROM THE TOWN'S RIGHT-OF-WAY MANAGEMENT UNIT.
- 7. ALL SURVEY POINTS SHALL BE VERIFIED IN THE FIELD BY THE CONTRACTOR PRIOR TO CONSTRUCTION. ANY DISCREPANCIES BETWEEN THE DRAWINGS AND THE LAYOUT SHALL BE REPORTED TO THE CONSULTING ENGINEER/TOWN AND THE CONSULTING ENGINEER/CITY SHALL NOTIFY THE CITY OF THE NECESSARY CHANGES.
- 8. CONTRACTOR SHALL VERIFY AND MATCH EXISTING PAVEMENT STRUCTURE IN DEPTH AND MATERIAL. ANY DISCREPANCIES BETWEEN EXISTING AND LATEST STANDARD PAVEMENT STRUCTURE SHALL BE REPORTED TO THE CONSULTANT PRIOR TO COMMENCEMENT OF CONSTRUCTION AND APPROPRIATE ACTION TAKEN TO THE SATISFACTION OF THE TOWN OF EAST
- 9. ANY DAMAGE TO PROPERTY ADJACENT TO THE CONSTRUCTION SITE SHALL BE THE RESPONSIBILITY OF THE CONTRACTOR.
- 10. SIGNAGE (BUILDING ADDRESS) TO BE VISIBLE FROM THE STREET.

#### **GRADING NOTES:**

- 1. ALL AREA GRADING AND RESULTING DRAINAGE PATTERNS SHALL REMAIN AS EXISTING AND SHALL NOT ADVERSELY AFFECT ADJACENT LANDS.
- 2. NO ALTERATIONS TO EXISTING BOUNDARY ELEVATIONS OR ADJACENT LANDS SHALL BE UNDERTAKEN UNLESS WRITTEN AGREEMENT WITH THE ADJACENT PROPERTY OWNER IS OBTAINED AND SUBMITTED IN A FORMAT ACCEPTABLE TO THE TOWN.

— EX. GRANULAR SURFACE

- PROPOSED 120m² AREA (APPROX.

(ASSUMED 40% VOID RATIO)


1.0mWx120mL) x 1.0mH OF STORMWATER INFILTRATION TRENCH COMPRISED OF COMPACTED 50mmø CLEAR STONE WRAPPED IN FILTER FABRIC FOR STORMWATER PURPOSES

PROP. 2 - 150mmø PERFORATED SUBDRAIN WRAPPED IN FILTER SOCK TO BE INSTALLED ALONG ENTIRE LENGTH OF INFILTRATION TRENCH

(±120mL ea) TO AID IN STORM DRAINAGE CAPTURE AND DISTRIBUTION

- 3. ALL SWALES OR DITCHES HAVING A VELOCITY IN EXCESS OF 1.5 METRES/SECOND SHALL BE DESIGNED TO INCORPORATE EROSION PROTECTION.
- 4. MAXIMUM PONDING DEPTH OF 0.3m.

(REFER TO PLAN VIEW FOR LOCATION)

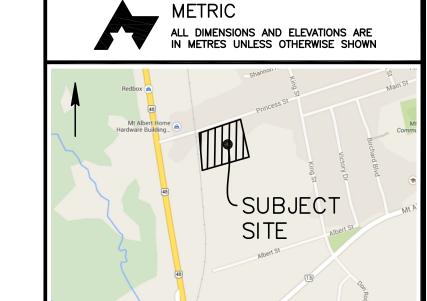

KEY PLAN onderosa **BENCH MARK:** 

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N.T.S.

### LEGEND

123.45 EXISTING ELEVATION

123.45 PROPOSED ELEVATION **XBW.** 123.45 PROP BOTTOM OF RETAINING WALL ELEV

× TW. 123.45 PROP TOP OF RETAINING WALL ELEV

×BC. 123.45 PROP BOTTOM OF CURB ELEVATION × TC. 123.45 PROP TOP OF CURB ELEVATION XSW. 123.45 PROP SWALE ELEVATION

×CB. 123.45 PROP TOP OF CATCHBASIN ELEVATION ×CB./NV 123.45 PROP ELEVATION OF CATCHBASIN INVERT

DRAINAGE FLOW DIRECTION AND SLOPE PROP OVERLAND FLOW DIRECTION

▼ V&B EX. VALVE AND BOX

MH.1A EX. SANITARY MANHOLE

-♦-H EX.FH EX. VALVED HYDRANT

FFE = 123.45 ELEVATION AT FIRST FINISHED FLOOR TFW = 123.45 ELEVATION AT TOP OF FOUNDATION WALL

EX. GRAVEL PARKING LOT AND OUTDOOR STORAGE AREA

ISSUED FOR TOWN SITE PLAN APPROVAL P.F.A. 10 JAN 2023 REVISION BY DATE

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REVISIONS

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www.fabianpapa.com

MUNICIPALITY:

TOWN OF EAST GWILLIMBURY ENGINEERING AND CONSTRUCTION SERVICES

PROJECT NAME:

23 PRINCESS STREET INDUSTRIAL PROPERTY USE

DRAWING TITLE:

SITE GRADING PLAN



P.F.A. DWN BY: DESIGNED BY: P.F.A. CHECKED BY: P.F.A. SCALE: 1:300 DEC. 2022 DATE:

SHEET NO: 2 OF 3

PROJECT NO. 14135

SGP-1

REV. NO.




#### **EROSION AND SEDIMENT CONTROL NOTES:**

- 1. SEDIMENT BARRIERS, CHECK DAMS, AND TEMPORARY CONSTRUCTION ACCESS TO BE INSTALLED PRIOR TO THE
- BEGINNING OF CONSTRUCTION. 2. ALL SEDIMENT CONTROL DEVICES TO BE ROUTINELY INSPECTED AND MAINTAINED IN PROPER WORKING ORDER UNTIL AREA IS
- 4. SEDIMENT CONTROL FENCE TO BE AS PER DETAIL ON THIS PLAN 5. ALL CONSTRUCTION VEHICLES TO ENTER AND EXIT SITE FROM TEMPORARY CONSTRUCTION ACCESS.
- 6. ALL TOPSOIL STOCKPILES (IF ANY) TO BE SURROUNDED WITH SEDIMENT CONTROL FENCING.
- 7. STREET SWEEPING, CATCH BASIN CLEANING AND DUST CONTROL ARE THE RESPONSIBILITY OF THE DEVELOPER AND MUST BE KEPT UNDER CONTROL ON ALL ROADWAYS TO THE SATISFACTION OF



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# terrafix geosynthetics inc.

# S100B

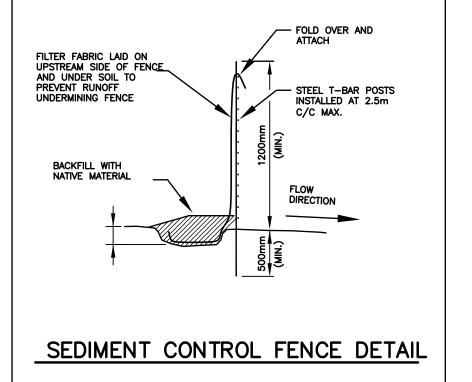The S100B (Straw Single Net) erosion control blanket (ECB) consists of the finest available agricultural straw with 75% four-inch fibers or greater fiber length, and is certified weed seed free. Product is 100% biodegradable. The straw fibers are evenly distributed throughout the entire area of the blanket. The top of each blanket is covered with biodegradable Jute netting.

**Product Nomenclature & Properties** 

= 100% straw
= the top and bottom of each blanket is covered with biodegradable Jute netting.
= biodegradable Jute netting

## Index & Bench Scale Testing

Test Description	Test Method	Test Results
Thickness	ASTM D6525	0.31 in (7.87 mm)
Light Penetration	ASTM D6567	8.60%
Mass per Unit Area	ASTM D6475	0.43 lb/yd² (233 g/m²)
MD - Tensile Strength (max.)	ASTM D6818	199.2 lb/ft (2.92 kN/m)
TD - Tensile Strength (max.)	ASTM D6818	121.2 lb/ft (1.78 kN/m)
MD - Elongation	ASTM D6818	5.50%
TD - Elongation	ASTM D6818	4.50%
Water Absorption	ASTM D1117/ECTC	409.00%
Bench-Scale Rain Splash	ECTC Method 2	SLR = 6.49 @ 2 in/hr
Bench-Scale Rain Splash	ECTC Method 2	SLR = 8.94 @ 4 in/hr
Bench-Scale Rain Splash	ECTC Method 2	SLR = 12.33 @ 6 in/hr
Bench-Scale Shear	ECTC Method 3	1.45 lb/ft² @ 0.5" soil los
		†

ECTC Method 4

Design Values

• "C" factor

• Shear Stress (Unvegetated) = 1.55 lb/ft² (74 Pa) Velocity (Unvegetated) = 4.5 ft/s (1.4 m/sec) ≤ 12 months

Standard Roll Details Width Length Area Weight\*

2.4m (8ft) Standard 34.3m (112.5ft) 83.6m<sup>2</sup> (100yd<sup>2</sup>) 22.7kg (50lb) Mass per Unit Area (± 10%) 0.27 kg/m² (0.50 lb/yd²)

Net Openings (FibreNet® - Jute 25.4 mm x 12.7 mm (≈ 1.0 in x 0.5 in) \*Weight is based on a dry fiber weight basis at time of manufacture. Baseline moisture content of straw and coconut fibers is 15% and 20%, respectively.

PHONE: (416)674-0363 • **www.terrafixgeo.com** • FAX: (416)674-1159 455 Homer Ave., Toronto, ON, M&W 4W9

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MOUNT ALBERT INVESTMENT

CORPORATION



MUNICIPALITY:

TOWN OF EAST GWILLIMBURY ENGINEERING AND CONSTRUCTION SERVICES

PROJECT NAME:

23 PRINCESS STREET INDUSTRIAL PROPERTY USE

DRAWING TITLE: **EROSION & SEDIMENT** CONTROL PLAN



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ESC-1